



AMERICAN TOWER®

ATC SITE NAME: CANOGA PARK CA 2

ATC SITE NUMBER: 300721

AT&T PACE NUMBERS: MRLOS090549, MRLOS090579,

MRLOS090574, MRLOS085918, MRLOS090559,

MRLOS090569

AT&T SITE ID: CLU1932 AT&T FA CODE:10068723

AT&T SITE NAME: MRLOS090579

SITE ADDRESS: 6543 CORBIN AVENUE

WOODLAND HILLS, CA 91335-5764

AT&T AMENDMENT PLAN



LOCATION MAP

SHEET INDEX PROJECT DESCRIPTION **COMPLIANCE CODE** PROJECT SUMMARY SHEET THE PROPOSED PROJECT INCL<mark>UDES MODIFYING GROUND BASED</mark> ALL WORK SHALL BE PERFORMED AND MATERIALS INSTALLED SITE ADDRESS: DESCRIPTION REV: DATE: BY: AND TOWER MOUNTED EQUIPMENT AS INDICATED PER BELOW: IN ACCORDANCE WITH THE CURRENT EDITIONS OF THE 6543 CORBIN AVENUE FOLLOWING CODES AS ADOPTED BY THE LOCAL G-001 TITLE SHEET Α 12/23/2021 SA WOODLAND HILLS, CA 91335-5764 GOVERNMENT AUTHORITIES. NOTHING IN THESE PLANS IS REMOVE (6) ANTENNA(s), (12) RRU(s), (12) DIPLEXER(s), (6) TMA(s), TO BE CONSTRUED TO PERMIT WORK NOT CONFORMING TO COUNTY: LOS ANGELES (1) SQUID AND (9) 7/8" COAX CABLE(s) G-002 **GENERAL NOTES** 12/23/2021 SA INSTALL (9) ANTENNA(S), (9) RRU(S) AND (6) DIPLEXER(s) C-001 OVERALL SITE PLAN 12/23/2021 SA Α GEOGRAPHIC COORDINATES: 2019 CALIFORNIA ADMINISTRATIVE CODE EXISTING (6) ANTENNA(s), (9) RRU(s), (6) TMA(s), (4) SQUID(s), 2019 CALIFORNIA BUILDING CODE LATITUDE: 34.19004684 7/8" COAX CABLE(s), (4) 1/4" COAX CABLE(s), (1) 3/8" COAX CABLE, C-101 DETAILED SITE PLAN 12/23/2021 SA Α 2019 CALIFORNIA RESIDENTAL CODE (6) 0.74" DC CABLE(s), (2) 0.78" DC CABLE(s) AND (2) 0.39" HYBRID LONGITUDE: -118 56271043 CABLE(s) TO REMAIN C-102 DETAILED EQUIPMENT LAYOUTS 12/23/2021 SA 2019 CALIFORNIA ELECTRICAL CODE GROUND ELEVATION: 750' AMSL 2019 CALIFORNIA PLUMBING CODE **GROUND WORK:** C-201 TOWER ELEVATIONS 12/23/2021 SA 2019 CALIFORNIA ENERGY CODE ZONING INFORMATION: REMOVE (1) 5216 BBU 2019 CALIFORNIA FIRE CODE C-401 RESCHEDULE & ANTENNA INFORMATION 12/23/2021 SA Α 2019 CALIFORNIA EXISTING BUILDING CODE JURISDICTION: CITY OF LOS ANGELES EXISTING (3) RRU(s), (1) 5216 BBU, (1) 6630 BBU AND (2) XMU(s) TO 2018 INTERNATIONAL BUILDING CODE (IBC) APN: 2134-024-019 SA C-501 CONSTRUCTION DETAILS 12/23/2021 10. NATIONAL ELECTRIC CODE (NEC) ZONING CODE: A-1 SA C-502 CONSTRUCTION DETAILS 12/23/2021 11. LOCAL BUILDING CODE PROJECT NOTES 12. CITY/COUNTY ORDINANCES PROJECT TEAM GR-501 GROUNDING DETAILS 12/23/2021 SA Α THE FACILITY IS UNMANNED. A TECHNICIAN WILL VISIT THE SITE APPROXIMATELY ONCE A SUPPLEMENTAL R-601 TOWER OWNER: APPLICANT: MONTH FOR ROUTINE INSPECTION AND MAINTENANCE. THE PROJECT WILL NOT RESULT IN ANY SIGNIFICANT LAND AMERICAN TOWER AT&T MOBILITY DISTURBANCE OR EFFECT OF STORM WATER DRAINAGE 10 PRESIDENTIAL WAY 2002 PISGAH CHURCH RD, NO SANITARY SEWER, POTABLE WATER OR TRASH DISPOSAL STF 300 IS REQUIRED WOBURN, MA 01801 HANDICAP ACCESS IS NOT REQUIRED. GREENSBORO, NC 27455 UTILITY COMPANIES THE PROJECT DEPICTED IN THESE PLANS QUALIFIES AS AN ENGINEER: ELIGIBLE FACILITIES REQUEST ENTITLED TO EXPEDITED POWER COMPANY: TRD REVIEW UNDER 47 U.S.C. § 1455(A) AS A MODIFICATION OF AN PHONE: TBD EXISTING WIRELESS TOWER THAT INVOLVES THE COLLOCATION, REMOVAL, AND/OR REPLACEMENT OF TELEPHONE COMPANY: TBD TRANSMISSION EQUIPMENT THAT IS NOT A SUBSTANTIAL CHANGE UNDER CFR § 1.61000 (B)(7). PHONE: TBD PROPERTY OWNER: VERIZON NO PAY VENDOR PROJECT LOCATION DIRECTIONS 6543 CORBIN AVENUE RESEDA, CA 91335-5764 FROM I 405 & US 101 FRWY: TAKE 101 NORTH "VENTURA." TO TAMPA AVE, EXIT AND TURN RIGHT. TO VICTORY, TURN LEFT. TO CORBIN AVE, TURN RIGHT. PROCEED 0.2 MILE TO MONOPOLE ON Know what's below. Call before you dig.



THE USE AND PUBLICATION OF THESE DRAWINGS SHALL BE RESTRICTED TO THE ORIGINAL SITE FOR WHICH THEY ARE PREPARED. ANY USE OR DISCLOSURE OTHER THAN THAT WHICH RELATES TO AMERICAN TOWER OR THE SPECIFIED CARRIER IS STRICTLY PROHIBITED. NEITHER THE ARCHITECT NOR THE ENGINEER WILL BE PROVIDING ON-SITE CONSTRUCTION REVIEW OF THIS PROJECT. CONTRACTOR(S) MUST VERIFY ALL DIMENSIONS AND ADVISE AMERICAN TOWER OR THE SPECIFIED CARRIER OF ANY DISCREPANCIES. ANY PRIOR ISSUANCE OF THIS DRAWING IS SUPERSEDED BY THE LATEST VERSION.

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AT&T SITE NAME:

MRLOS090579

SITE ADDRESS: 6543 CORBIN AVENUE WOODLAND HILLS. CA 91335-5764

SEAL





	11	DATE DRAWN:	12/23/2021
_	П	ATC JOB NO:	13749878_G3
	П	CUSTOMER ID:	CLU1932
	П	CUSTOMER #:	10068723

TITLE SHEET

SHEET NUMBER

G-001

GENERAL CONSTRUCTION NOTES:

- OWNER FURNISHED MATERIALS, AT&T "THE COMPANY" WILL PROVIDE AND THE CONTRACTOR WILL INSTALL
 - A. BTS EQUIPMENT FRAME (PLATFORM) AND ICEBRIDGE SHELTER (GROUND BUILD/CO-LOCATE ONLY)
 - AC/TELCO INTERFACE BOX (PPC)
 - ICE BRIDGE (CABLE TRAY WITH COVER) (GROUND BUILD/CO-LOCATE ONLY, GC TO FURNISH AND INSTALL FOR ROOFTOP INSTALLATION)

 - D. TOWERS, MONOPOLES
 - TOWER LIGHTING
 - GENERATORS & LIQUID PROPANE TANK
 - ANTENNA STANDARD BRACKETS, FRAMES AND PIPES FOR MOUNTING
 - ANTENNAS (INSTALLED BY OTHERS)
 - TRANSMISSION LINE
 - TRANSMISSION LINE JUMPERS
 - TRANSMISSION LINE CONNECTORS WITH WEATHERPROOFING KITS
 - TRANSMISSION LINE GROUND KITS
 - HANGERS
 - HOISTING GRIPS
 - O. BTS EQUIPMENT
- THE CONTRACTOR IS RESPONSIBLE TO PROVIDE ALL OTHER MATERIALS FOR THE COMPLETE INSTALLATION OF THE SITE INCLUDING, BUT NOT LIMITED TO, SUCH MATERIALS AS FENCING, STRUCTURAL STEEL SUPPORTING SUB-FRAME FOR PLATFORM, ROOFING LABOR AND MATERIALS GROUNDING RINGS GROUNDING WIRES COPPER-CLAD OR XIT CHEMICAL GROUND ROD(S), BUSS BARS, TRANSFORMERS AND DISCONNECT SWITCHES WHERE APPLICABLE, TEMPORARY ELECTRICAL POWER CONDUIT, LANDSCAPING COMPOUND STONE, CRANES, CORE DRILLING, SLEEPERS AND RUBBER MATTING, REBAR, CONCRETE CAISSONS, PADS AND/OR AUGER MOUNTS, MISCELLANEOUS FASTENERS, CABLE TRAYS, NON-STANDARD ANTENNA FRAMES AND ALL OTHER MATERIAL AND LABOR REQUIRED TO COMPLETE THE JOB ACCORDING TO THE DRAWINGS AND SPECIFICATIONS. IT IS THE POSITION OF AT&T TO APPLY FOR PERMITTING AND CONTRACTOR RESPONSIBLE FOR PICKUP AND PAYMENT OF REQUIRED
- ALL WORK SHALL CONFORM TO ALL CURRENT APPLICABLE FEDERAL, STATE, AND LOCAL CODES, INCLUDING ANSI/EIA/TIA-222, AND COMPLY WITH ATC CONSTRUCTION
- CONTRACTOR SHALL CONTACT LOCAL 811 FOR IDENTIFICATION OF UNDERGROUND
- CONTRACTOR SHALL BE RESPONSIBLE FOR COORDINATING ALL REQUIRED
- ALL DIMENSIONS TO, OF, AND ON EXISTING BUILDINGS, DRAINAGE STRUCTURES, AND SITE IMPROVEMENTS SHALL BE VERIFIED IN FIELD BY CONTRACTOR WITH ALL DISCREPANCIES REPORTED TO THE ENGINEER.
- DO NOT CHANGE SIZE OR SPACING OF STRUCTURAL ELEMENTS
- DETAILS SHOWN ARE TYPICAL: SIMILAR DETAILS APPLY TO SIMILAR CONDITIONS UNLESS
- THESE DRAWINGS DO NOT INCLUDE NECESSARY COMPONENTS FOR CONSTRUCTION SAFETY WHICH SHALL BE THE SOLE RESPONSIBILITY OF THE CONTRACTOR
- CONTRACTOR SHALL BRACE STRUCTURES UNTIL ALL STRUCTURAL ELEMENTS NEEDED FOR STABILITY ARE INSTALLED. THESE ELEMENTS ARE AS FOLLOWS: LATERAL BRACING
- CONTRACTOR SHALL DETERMINE EXACT LOCATION OF EXISTING UTILITIES, GROUNDS DRAINS, DRAIN PIPES, VENTS, ETC, BEFORE COMMENCING WORK
- INCORRECTLY FABRICATED, DAMAGED, OR OTHERWISE MISFITTING OR NONCONFORMING MATERIALS OR CONDITIONS SHALL BE REPORTED TO THE AT&T REP PRIOR TO REMEDIAL OR CORRECTIVE ACTION, ANY SUCH REMEDIAL ACTION SHALL REQUIRE WRITTEN APPROVAL BY THE AT&T REP PRIOR TO PROCEEDING.
- EACH CONTRACTOR SHALL COOPERATE WITH THE AT&T REP, AND COORDINATE HIS WORK WITH THE WORK OF OTHERS.
- CONTRACTOR SHALL REPAIR ANY DAMAGE CAUSED BY CONSTRUCTION OF THIS PROJECT TO MATCH EXISTING PRE-CONSTRUCTION CONDITIONS TO THE SATISFACTION OF THE AT&T CONSTRUCTION MANAGER.
- ALL CABLE/CONDUIT ENTRY/EXIT PORTS SHALL BE WEATHERPROOFED DURING 15. INSTALLATION LISING A SILICONE SEALANT
- WHERE EXISTING CONDITIONS DO NOT MATCH THOSE SHOWN IN THIS PLAN SET. CONTRACTOR SHALL NOTIFY THE AT&T REP AND ENGINEER OF RECORD IMMEDIATELY
- CONTRACTOR SHALL ENSURE ALL SUBCONTRACTORS ARE PROVIDED WITH A COMPLETE AND CURRENT SET OF DRAWINGS AND SPECIFICATIONS FOR THIS PROJECT
- CONTRACTOR SHALL REMOVE ALL RUBBISH AND DEBRIS FROM THE SITE AT THE END OF
- CONTRACTOR SHALL COORDINATE WORK SCHEDULE WITH AMERICAN TOWER CORPORATION (ATC) AND TAKE PRECAUTIONS TO MINIMIZE IMPACT AND DISRUPTION OF OTHER OCCUPANTS OF THE FACILITY
- CONTRACTOR SHALL FURNISH AT&T AND AMERICAN TOWER CORPORATION (ATC) WITH A PDF MARKED UP AS-BUILT SET OF DRAWINGS UPON COMPLETION OF WORK.
- PRIOR TO SUBMISSION OF BID. CONTRACTOR SHALL COORDINATE WITH AT&T REP TO DETERMINE WHAT, IF ANY, ITEMS WILL BE PROVIDED. ALL ITEMS NOT PROVIDED SHALL BE PROVIDED AND INSTALLED BY THE CONTRACTOR. CONTRACTOR WILL INSTALL ALL
- 22. PRIOR TO SUBMISSION OF BID, CONTRACTOR SHALL COORDINATE WITH AT&T REP TO

- DETERMINE IF ANY PERMITS WILL BE OBTAINED BY CONTRACTOR. ALL REQUIRED PERMITS NOT OBTAINED BY AT&T MUST BE OBTAINED, AND PAID FOR, BY THE
- CONTRACTOR SHALL INSTALL ALL SITE SIGNAGE IN ACCORDANCE WITH AT&T SPECIFICATIONS AND REQUIREMENTS
- 24. CONTRACTOR SHALL SUBMIT ALL SHOP DRAWINGS TO AT&T FOR REVIEW AND APPROVAL PRIOR TO FABRICATION.
- ALL EQUIPMENT SHALL BE INSTALLED ACCORDING TO MANUFACTURER'S SPECIFICATIONS AND LOCATED ACCORDING TO AT&T SPECIFICATIONS, AND AS SHOWN
- THE CONTRACTOR SHALL SUPERVISE AND DIRECT THE PROJECT DESCRIBED HEREIN. THE CONTRACTOR SHALL BE SOLELY RESPONSIBLE FOR ALL THE CONSTRUCTION. MEANS METHODS, TECHNIQUES, SEQUENCES AND PROCEDURES AND FOR COORDINATING ALL PORTIONS OF THE WORK UNDER THE CONTRACT.
- CONTRACTOR SHALL NOTIFY AT&T REP A MINIMUM OF 48 HOURS IN ADVANCE OF POURING CONCRETE OR BACKFILLING ANY UNDERGROUND UTILITIES, FOUNDATIONS OR SEALING ANY WALL, FLOOR OR ROOF PENETRATIONS FOR ENGINEERING REVIEW AND
- 28. CONTRACTOR SHALL BE RESPONSIBLE FOR SITE SAFETY INCLUDING COMPLIANCE WITH ALL APPLICABLE OSHA STANDARDS AND RECOMMENDATIONS AND SHALL PROVIDE ALL NECESSARY SAFETY DEVICES INCLUDING PPE AND PPM AND CONSTRUCTION DEVICES SUCH AS WELDING AND FIRE PREVENTION, TEMPORARY SHORING, SCAFFOLDING, TRENCH BOXES/SLOPING, BARRIERS, ETC.
- THE CONTRACTOR SHALL PROTECT AT HIS OWN EXPENSE. ALL EXISTING FACILITIES AND SUCH OF HIS NEW WORK LIABLE TO INJURY DURING THE CONSTRUCTION PERIOD. ANY DAMAGE CAUSED BY NEGLECT ON THE PART OF THIS CONTRACTOR OR HIS REPRESENTATIVES, OR BY THE ELEMENTS DUE TO NEGLECT ON THE PART OF THIS CONTRACTOR OR HIS REPRESENTATIVES, EITHER TO THE EXISTING WORK, OR TO HIS WORK OR THE WORK OF ANY OTHER CONTRACTOR, SHALL BE REPAIRED AT HIS EXPENSE TO THE OWNER'S SATISFACTION.
- ALL WORK SHALL BE INSTALLE<mark>D IN A FIRST C</mark>LASS, NEAT AND WORKMANLIKE MANNER BY MECHANICS SKILLED IN THE TRADE INVOLVED. THE QUALITY OF WORKMANSHIP SHALL BE SUBJECT TO THE APP<mark>ROVAL OF THE</mark> AT&T REP. ANY WORK FOUND BY THE AT&T REP TO BE OF INFERIOR QUALITY AND/OR WORKMANSHIP SHALL BE REPLACED AND/OR REWORKED AT CONTRACTOR EXPENSE UNTIL APPROVAL IS OBTAINED.
- 31 IN ORDER TO ESTABLISH STANDARDS OF QUALITY AND PERFORMANCE, ALL TYPES OF MATERIALS LISTED HEREINAFTER BY MANUFACTURER'S NAMES AND/OR
 MANUFACTURER'S CATALOG NUMBER SHALL BE PROVIDED BY THESE MANUFACTURERS
- 32 AT&T FURNISHED FOLIDMENT SHALL BE PICKED-LIP AT THE AT&T WAREHOUSE NO. LATER THAN 48HR AFTER BEING NOTIFIED INSURED, STORED, UNCRATE, PROTECTED AND INSTALLED BY THE CONTRACTOR WITH ALL APPURTENANCES REQUIRED TO PLACE THE EQUIPMENT IN OPERATION, READY FOR USE. THE CONTRACTOR SHALL BE RESPONSIBLE FOR THE EQUIPMENT AFTER PICKING IT UP
- 33. AT&T OR HIS ARCHITECT/ENGINEER RESERVES THE RIGHT TO REJECT ANY EQUIPMENT OR MATERIALS WHICH, IN HIS OWN OPINION ARE NOT IN COMPLIANCE WITH THE CONTRACT DOCUMENTS, EITHER BEFORE OR AFTER INSTALLATION AND THE EQUIPMENT SHALL BE REPLACED WITH EQUIPMENT CONFORMING TO THE REQUIREMENTS OF THE CONTRACT DOCUMENTS BY THE CONTRACTOR AT NO COST TO AT&T OR THEIR

SPECIAL CONSTRUCTION ANTENNA INSTALLATION NOTES:

- WORK INCLUDED
 - ANTENNA AND COAXIAL CABLES ARE FURNISHED BY AT&T UNDER A SEPARATE CONTRACT. THE CONTRACTOR SHALL ASSIST ANTENNA INSTALLATION CONTRACTOR IN TERMS OF COORDINATION AND SITE ACCESS. ERECTION SUBCONTRACTOR SHALL BE RESPONSIBLE FOR THE PROTECTION OF
 - B. INSTALL ANTENNAS AS INDICATED ON DRAWINGS AND AT&T SPECIFICATIONS.
 - C. INSTALL GALVANIZED STEEL ANTENNA MOUNTS AS INDICATED ON DRAWINGS.
 - D. INSTALL FURNISHED GALVANIZED STEEL OR ALUMINUM WAVEGUIDE
 - CONTRACTOR SHALL PROVIDE FOUR (4) SETS OF SWEEP TESTS USING ANRITZU-PACKARD 8713B RF SCALAR NETWORK ANALYZER. SUBMIT FREQUENCY DOMAIN REFLECTOMETER(FDR) TESTS RESULTS TO THE PROJECT MANAGER. SWEEP TESTS SHALL BE AS PER ATTACHED RFS "MINIMUM FIELD TESTING RECOMMENDED FOR ANTENNA AND HELIAX COAXIAL CABLE SYSTEMS" DATED 10/5/93 TESTING SHALL BE PERFORMED BY AN INDEPENDENT TESTING SERVICE BE BOUND AND SUBMITTED WITHIN ONE WEEK OF WORK COMPLETION
 - INSTALL COAXIAL CABLES AND TERMINATING BETWEEN ANTENNAS AND EQUIPMENT PER MANUFACTURER'S RECOMMENDATIONS. WEATHERPROOF ALL CONNECTIONS BETWEEN THE ANTENNA AND EQUIPMENT PER MANUFACTURER'S REQUIREMENTS. TERMINATE ALL COAXIAL CABLE THREE (3) FEET IN EXCESS OF ENTRY PORT LOCATION UNLESS OTHERWISE STATED.
 - G. ANTENNA AND COAXIAL CABLE GROUNDING:
- ALL EXTERIOR #6 GREEN GROUND WIRE "DAISY CHAIN" CONNECTIONS ARE TO BE /EATHER SEALED WITH RFS CONNECTORS/SPLICE WEATHERPROOFING KIT #221213 OR FOUAL
- ALL COAXIAL CABLE GROUNDING KITS ARE TO BE INSTALLED ON STRAIGHT RUNS OF

ALL DISCREPANCIES FROM WHAT IS SHOWN ON THESE CONSTRUCTION DRAWINGS SHALL BE COMMUNICATED TO ATC ENGINEERING IMMEDIATELY FOR CORRECTION OR RE-DESIGN FAILURE TO COMMUNICATE DIRECTLY WITH ATC ENGINEERING OR ANY CHANGES FROM THE DESIGN CONDUCTED WITHOUT PRIOR APPROVAL FROM ATC ENGINEERING SHALL BE THE SOLE RESPONSIBILITY OF THE GENERAL CONTRACTOR.



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> AT&T SITE NAME: MRLOS090579

SITE ADDRESS 6543 CORBIN AVENUE

WOODLAND HILLS, CA 91335-5764






DATE DRAWN: | 12/23/2021 ATC JOB NO: 13749878 G3 CUSTOMER ID: CLU1932 CUSTOMER #: 10068723

GENERAL NOTES

SHEET NUMBER:

G-002

NOTES: 1. BOUNDARY LINES OBTAINED FROM CITY OF LOS ANGELES ONLINE GIS. 2. ZONING INFORMATION OBTAINED FROM A-1.

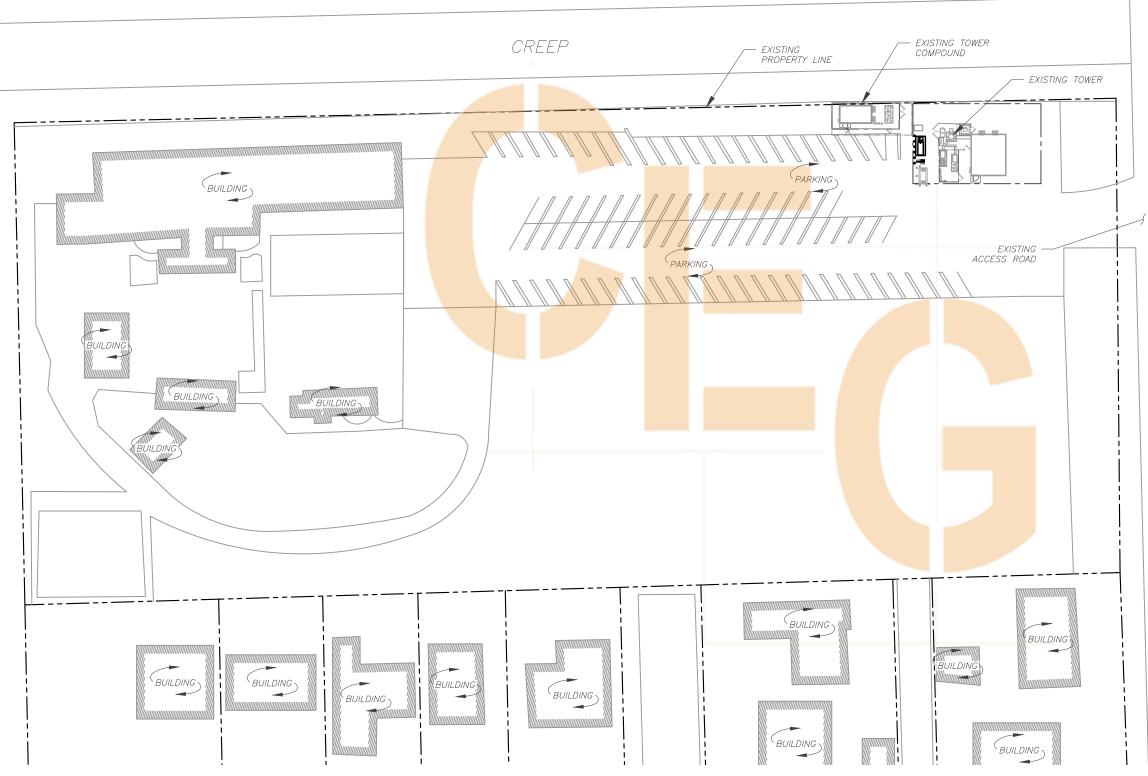

OVERALL SITE PLAN

GRAPHIC SCALE

(IN FEET) 1 UNIT = 60 FEET



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AT&T SITE NAME: MRLOS090579

SITE ADDRESS:

6543 CORBIN AVENUE WOODLAND HILLS, CA 91335-5764

SEAL

CORBIN





DATE DRAWN:	12/23/2021
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CUSTOMER ID:	CLU1932
CUSTOMER #:	10068723

OVERALL SITE PLAN

SHEET NUMBER:


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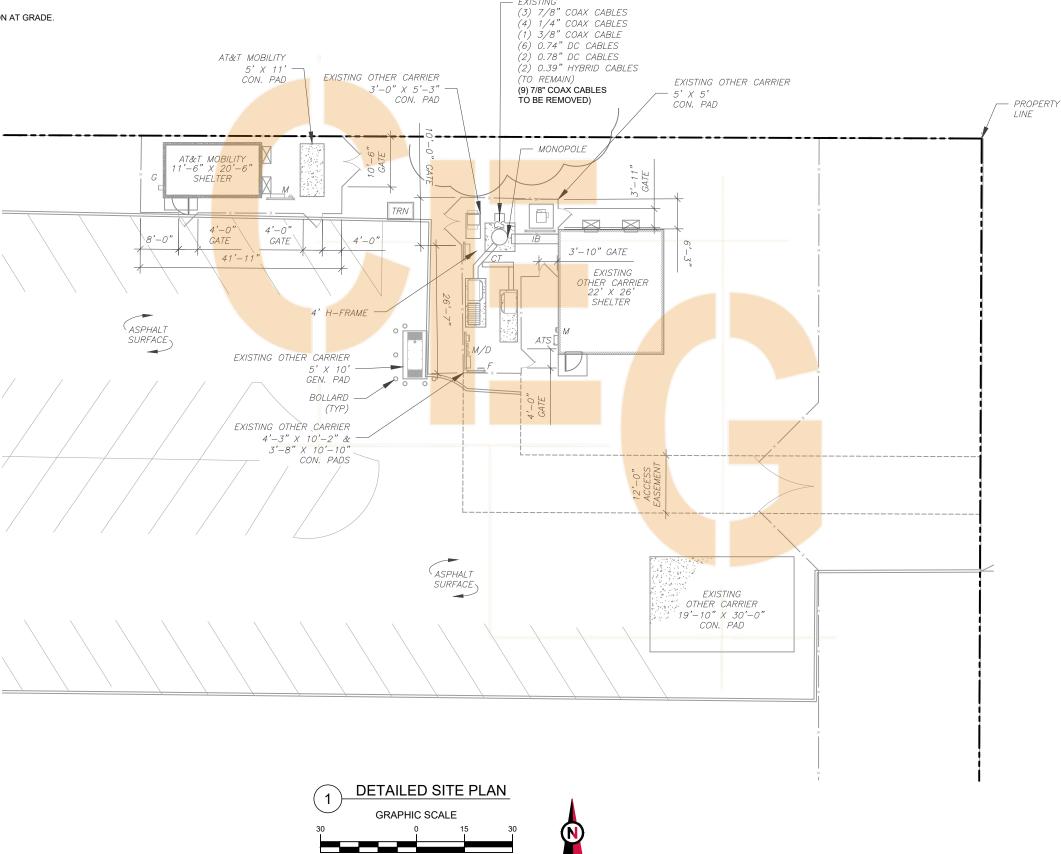
C-001

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SITE PLAN NOTES:

- THIS SITE PLAN REPRESENTS THE BEST PRESENT KNOWLEDGE AVAILABLE TO THE ENGINEER AT THE
 TIME OF THIS DESIGN. THE CONTRACTOR SHALL VISIT THE SITE PRIOR TO CONSTRUCTION AND VERIFY
 ALL EXISTING CONDITIONS RELATED TO THE SCOPE OF WORK FOR THIS PROJECT.
- 2. ICE BRIDGE, CABLE LADDER, COAX PORT, AND COAX CABLE ARE SHOWN FOR REFERENCE ONLY. CONTRACTOR SHALL CONFIRM THE EXACT LOCATION OF ALL PROPOSED AND EXISTING EQUIPMENT AND STRUCTURES DEPICTED ON THIS PLAN. BEFORE UTILIZING EXISTING CABLE SUPPORTS, COAX PORTS, INSTALLING NEW PORTS OR ANY OTHER EQUIPMENT, CONTRACTOR SHALL VERIFY ALL ASPECTS OF THE COMPONENTS MEET THE ATC SPECIFICATIONS.
- 3. THIS PROJECT INCLUDES NO INSTALL OR MODIFICATION AT GRADE.



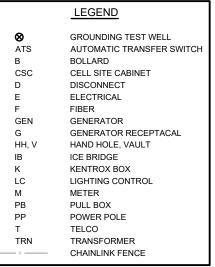

1 UNIT = 30 FEET



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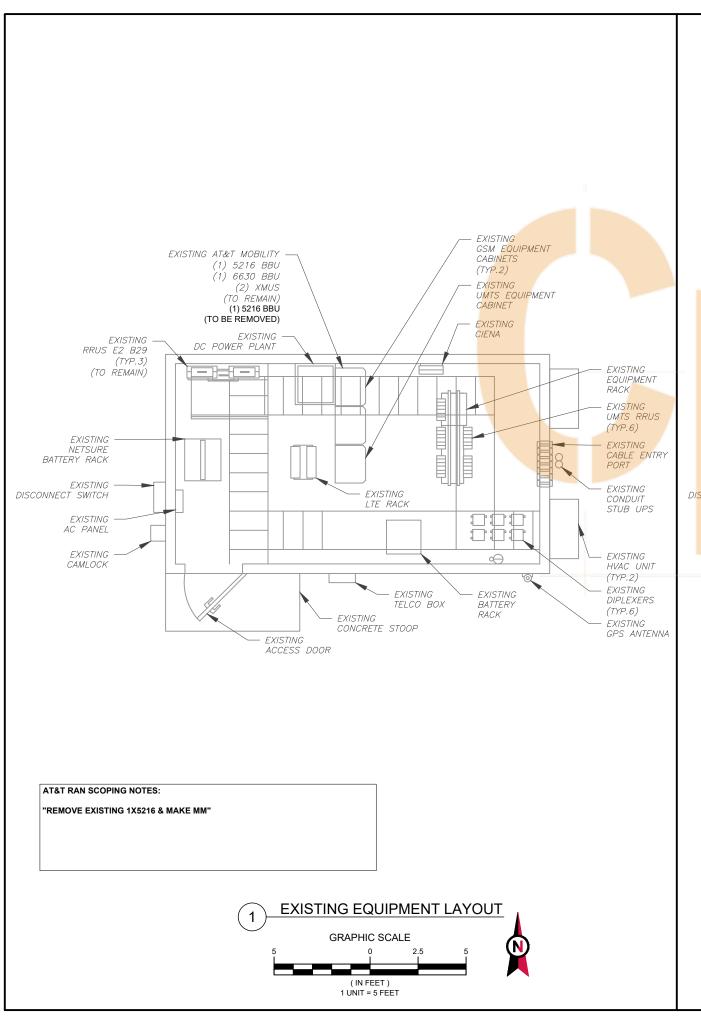
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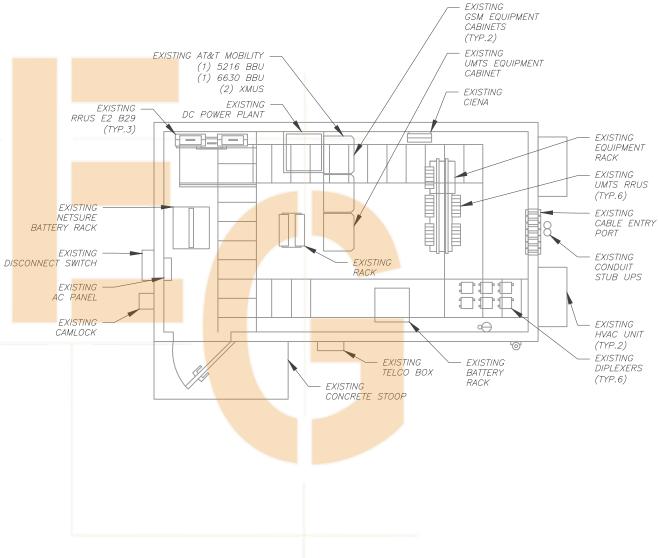
DETAILED SITE PLAN

C-101

REVISION

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PROPOSED EQUIPMENT LAYOUT

(IN FEET)

1 UNIT = 5 FÉET



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SEA






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DETAILED EQUIPMENT LAYOUTS

SHEET NUMBER:

C-102



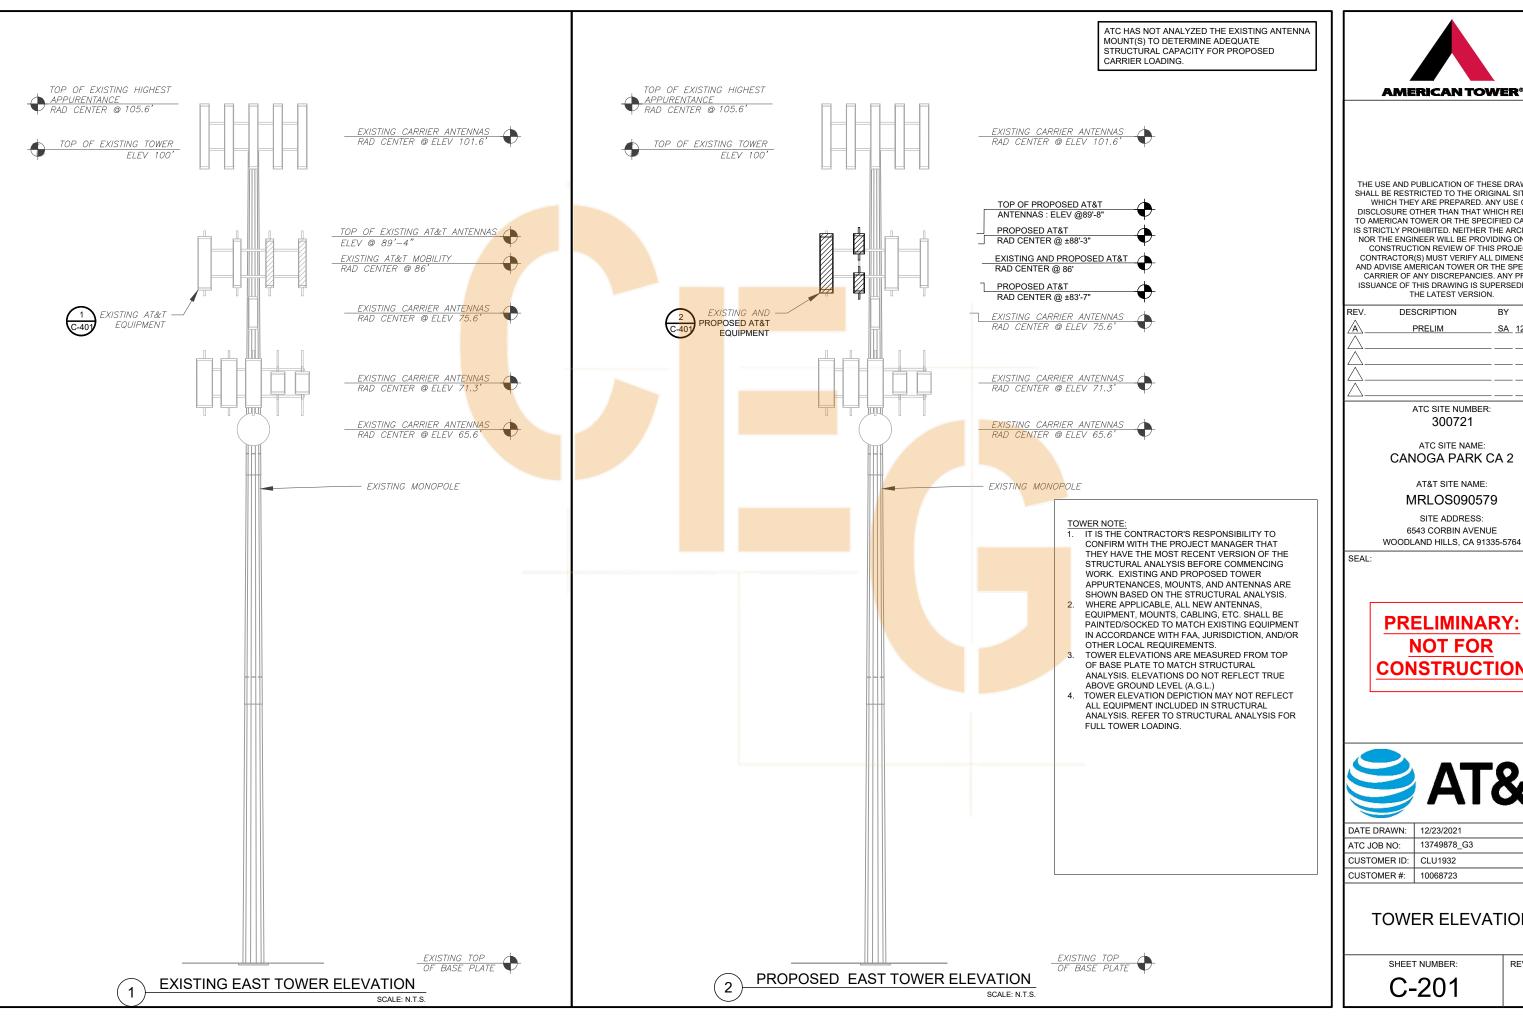

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CANOGA PARK CA 2


6543 CORBIN AVENUE





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TOWER ELEVATION



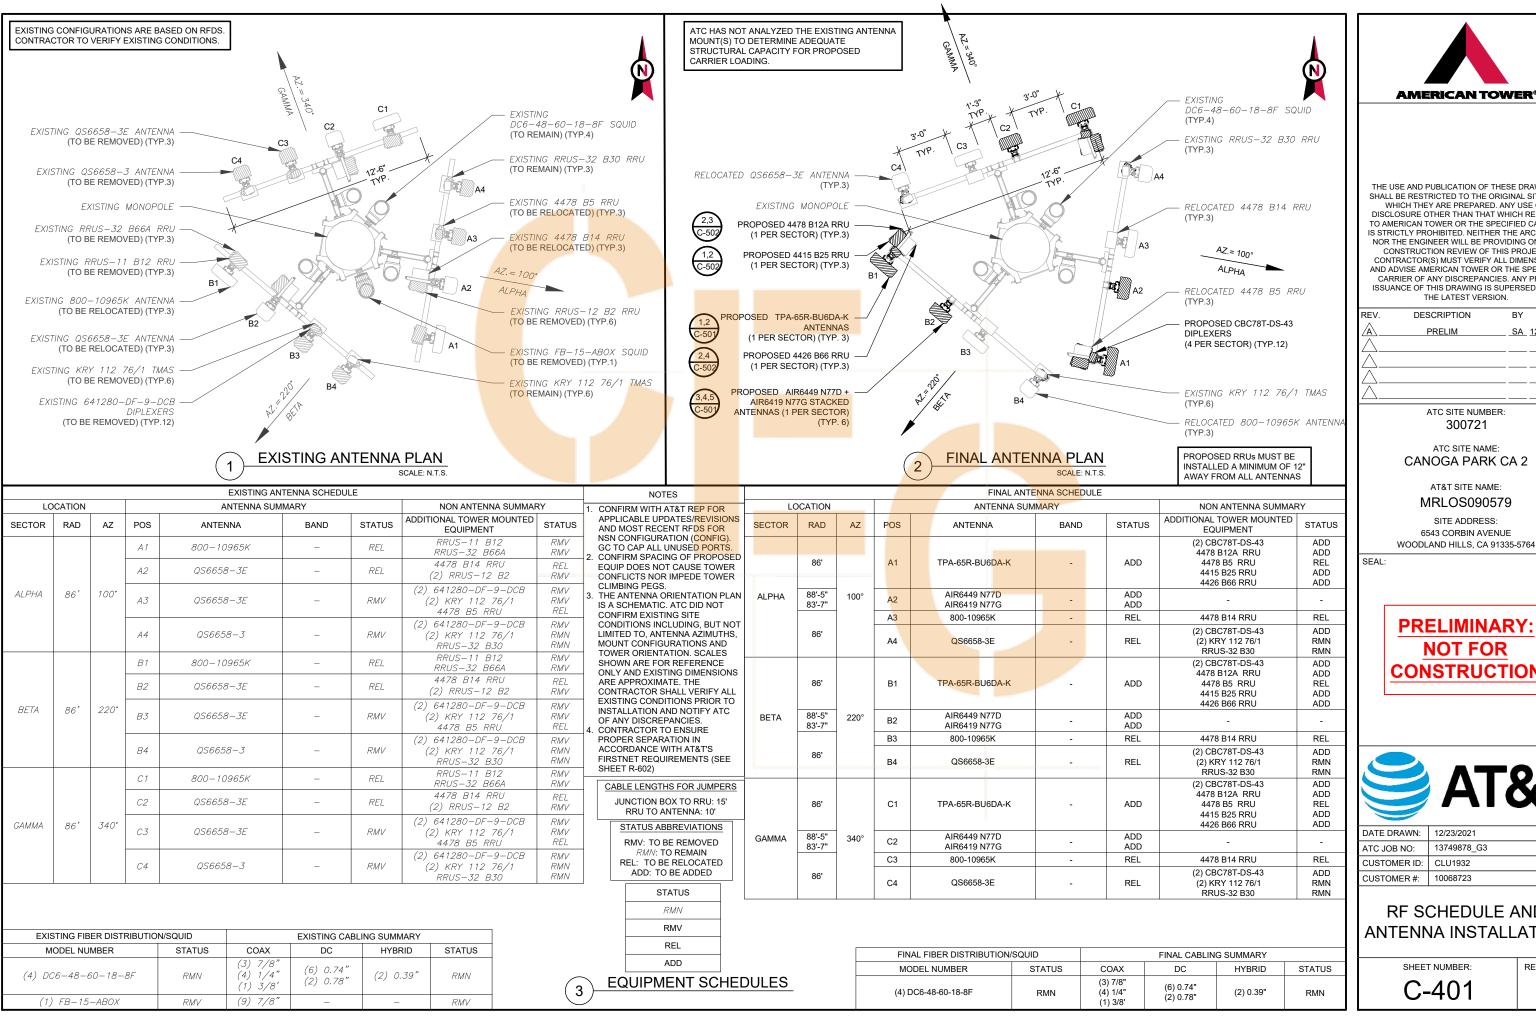

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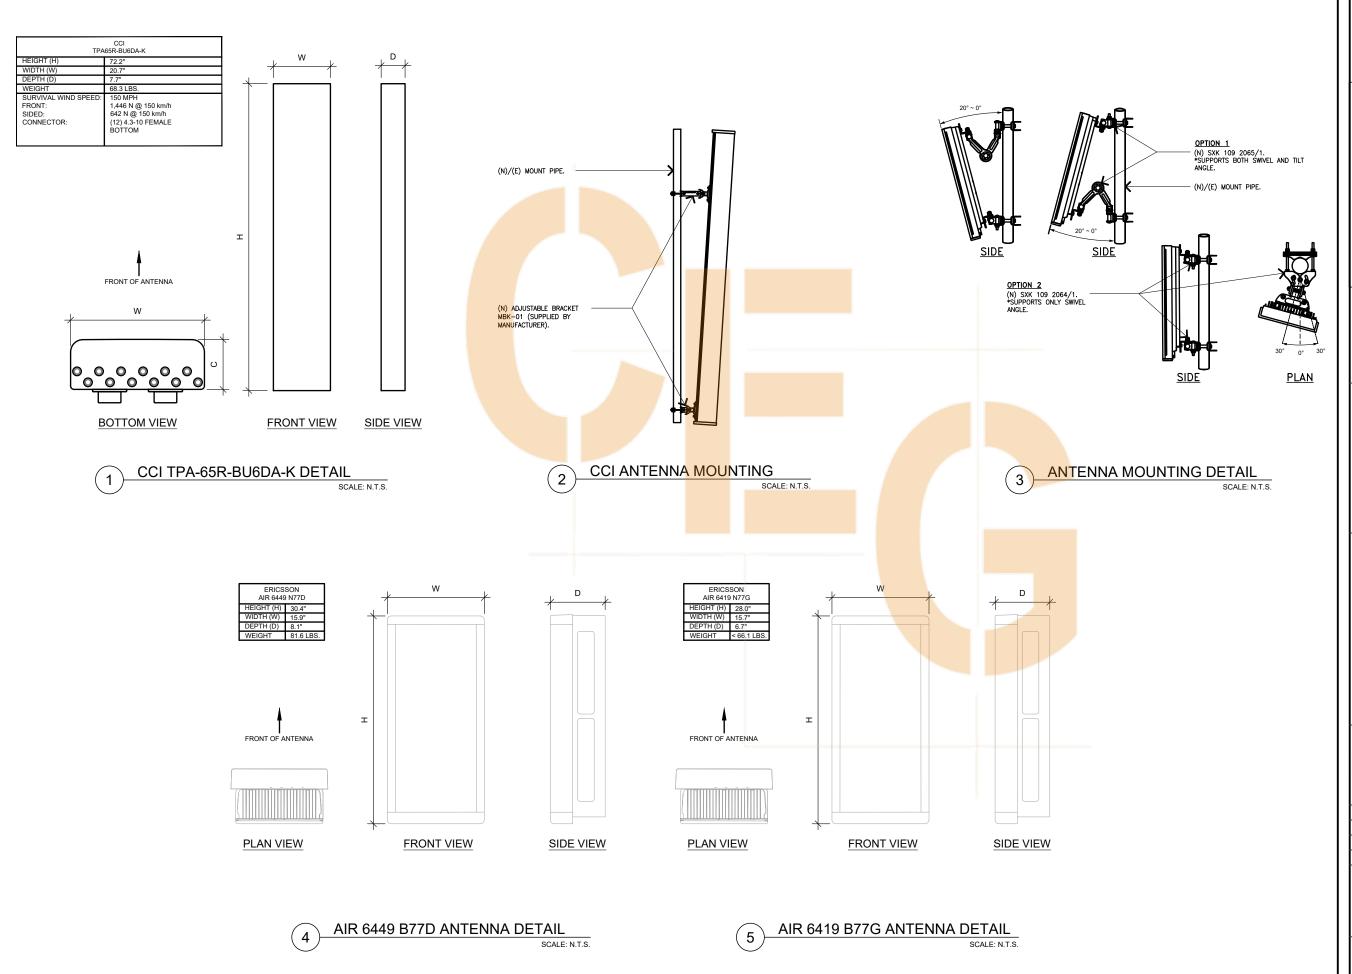
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CUSTOMER #:	10068723

RF SCHEDULE AND ANTENNA INSTALLATION





THE USE AND PUBLICATION OF THESE DRAWINGS SHALL BE RESTRICTED TO THE ORIGINAL SITE FOR WHICH THEY ARE PREPARED. ANY USE OR DISCLOSURE OTHER THAN THAT WHICH RELATES TO AMERICAN TOWER OR THE SPECIFIED CARRIER IS STRICTLY PROHIBITED. NEITHER THE ARCHITECT NOR THE ENGINEER WILL BE PROVIDING ON-SITE CONSTRUCTION REVIEW OF THIS PROJECT. CONTRACTOR(S) MUST VERIFY ALL DIMENSIONS AND ADVISE AMERICAN TOWER OR THE SPECIFIED CARRIER OF ANY DISCREPANCIES. ANY PRIOR ISSUANCE OF THIS DRAWING IS SUPERSEDED BY THE LATEST VERSION.

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ATC SITE NUMBER: 300721

ATC SITE NAME: CANOGA PARK CA 2

AT&T SITE NAME:

MRLOS090579

SITE ADDRESS: 6543 CORBIN AVENUE WOODLAND HILLS, CA 91335-5764

SEA






	DATE DRAWN:	12/23/2021
	ATC JOB NO:	13749878_G3
	CUSTOMER ID:	CLU1932
	CUSTOMER #:	10068723

CONSTRUCTION DETAILS

SHEET NUMBER:

C-501

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(3) 4478 B12A RRU

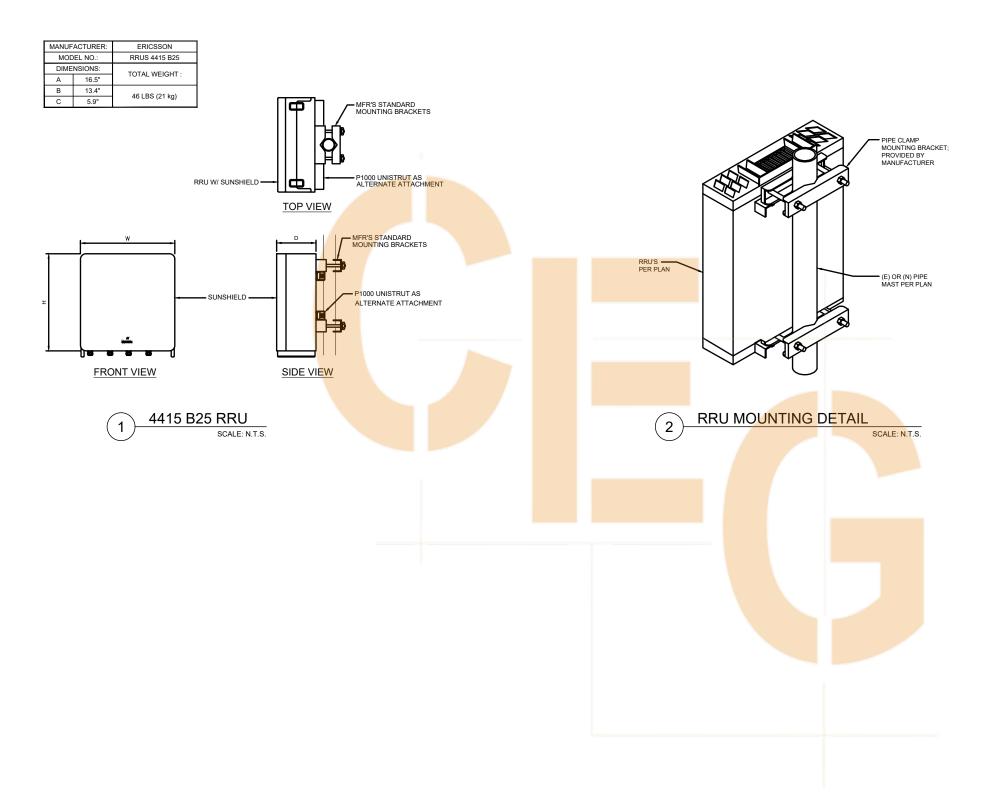SCALE: N.T.S.

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SCALE: N.T.S.



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REV.	DESCRIPTION	BY	DATE
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ATC SITE NUMBER: 300721

ATC SITE NAME:
CANOGA PARK CA 2

AT&T SITE NAME: MRLOS090579

SITE ADDRESS: 6543 CORBIN AVENUE WOODLAND HILLS, CA 91335-5764

SEA






	DATE DRAWN:	12/23/2021
	ATC JOB NO:	13749878_G3
	CUSTOMER ID:	CLU1932
	CUSTOMER #:	10068723

CONSTRUCTION DETAILS

SHEET NUMBER:

C-502

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ATC SITE NUMBER: 300721

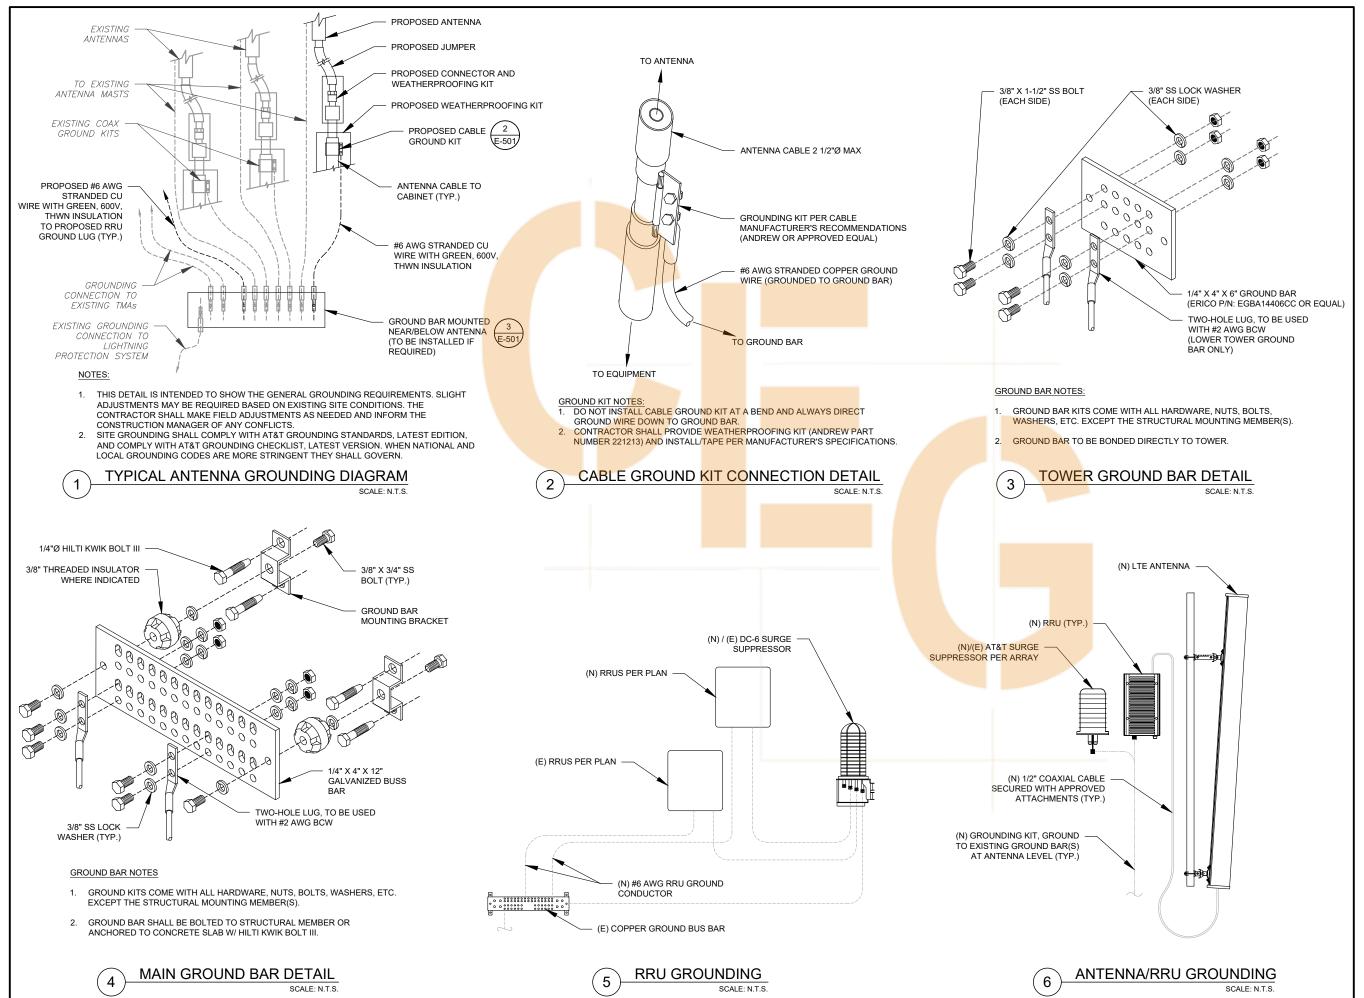ATC SITE NAME: CANOGA PARK CA 2

AT&T SITE NAME:

MRLOS090579

SITE ADDRESS: 6543 CORBIN AVENUE WOODLAND HILLS, CA 91335-5764

SEA





DATE DRAWN:	12/23/2021
ATC JOB NO:	13749878_G3
CUSTOMER ID:	CLU1932
CUSTOMER #:	10068723

GROUNDING DETAILS

SHEET NUMBER:

REVISION

GR-501

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SUPPLEMENTAL

SHEET NUMBER:

REVISION:

R-601

MOUNT ANALYSIS

NOTE: THIS SHEET WAS CREATED BY OTHERS AND PROVIDED AT THE REQUEST OF THE CUSTOMER WITHOUT EDIT. PLEASE REFERENCE THE MOUNT ANALYSIS REPORT FOR COMPLETE MOUNT ANALYSIS CALCULATIONS AND DETAILS. SUPPLEMENTAL PAGES INCLUDED IN THE CONSTRUCTION DRAWINGS ARE FOR REFERENCE ONLY. GENERAL CONTRACTOR IS TO VERYIFY THEY HAVE THE MOST RECENT MOUNT ANALYSIS PRIOR TO CONTRUCTION.